

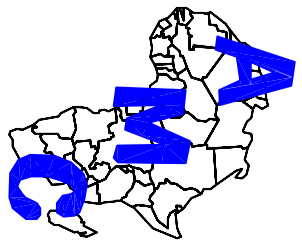


FIGURE 3.5


| | |
|---------------------------------------|--------------------------|
| AFRICAN MINING CONSULTANTS LTD | |
| P.O. BOX 20106, KITWE, ZAMBIA. | |
| PROJECT TITLE: | |
| MINE LAYOUT PLAN | |
| ORIGINATOR: IAD | CLIENT: AFRICO RESOURCES |
| DRAWN: EPM | DWG NAME: SITE PLAN.DWG |
| SCALE: 1 : 1500 | DATE: APR 04 |
| | REV NO: 0 |

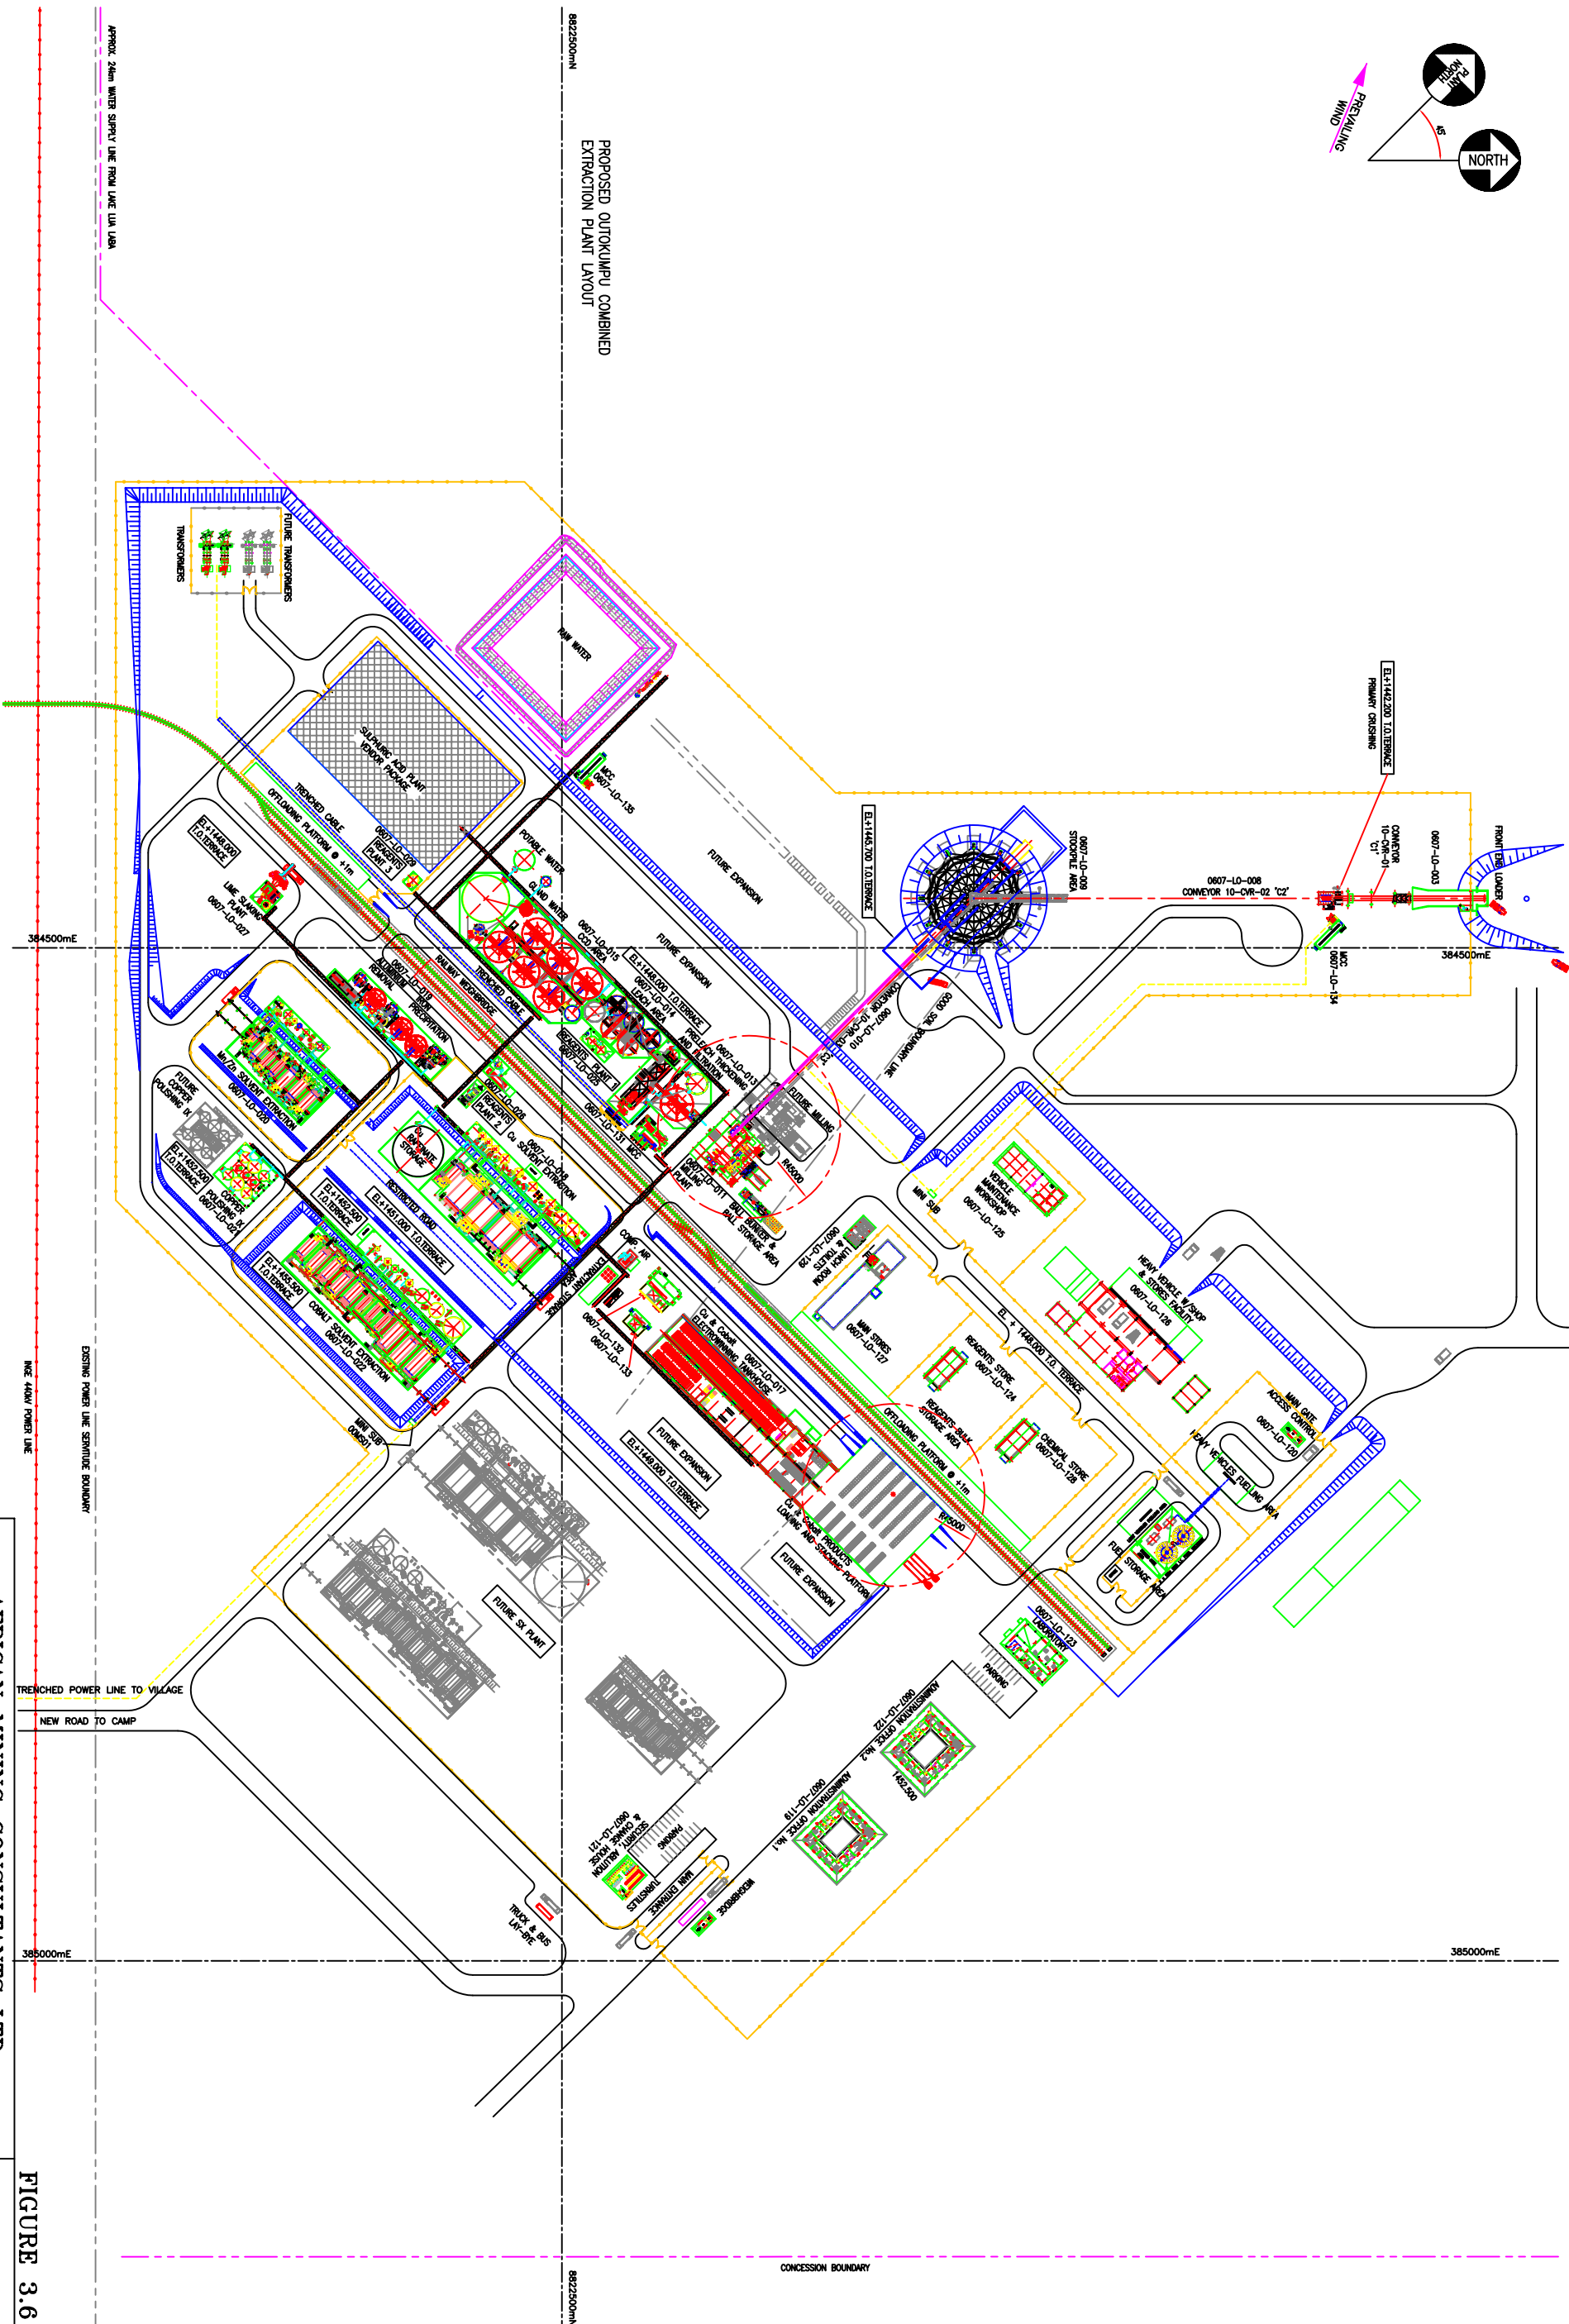

GRID Co-ORDINATE SYSTEM:
UTM (ZONE 35)
WGS 84 SPHEROID (m+27)

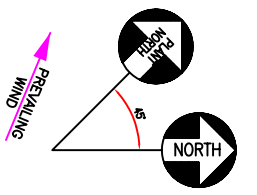

| | |
|--|---|
| <p>AFRICAN MINING CONSULTANTS LTD P.O. BOX 20106, KITWE, ZAMBIA.</p> | |
| <p>PROJECT TITLE: PROCESS PLANT LAYOUT</p> | |
| <p>ORIGINATOR: AD CLIENT: AFRICO RESOURCES LTD DRAWN: FPM</p> | <p>SCALE: NTS DATE: MAY'06 REV. NO: 0</p> |

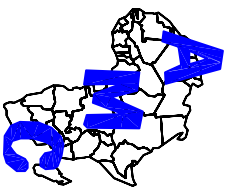

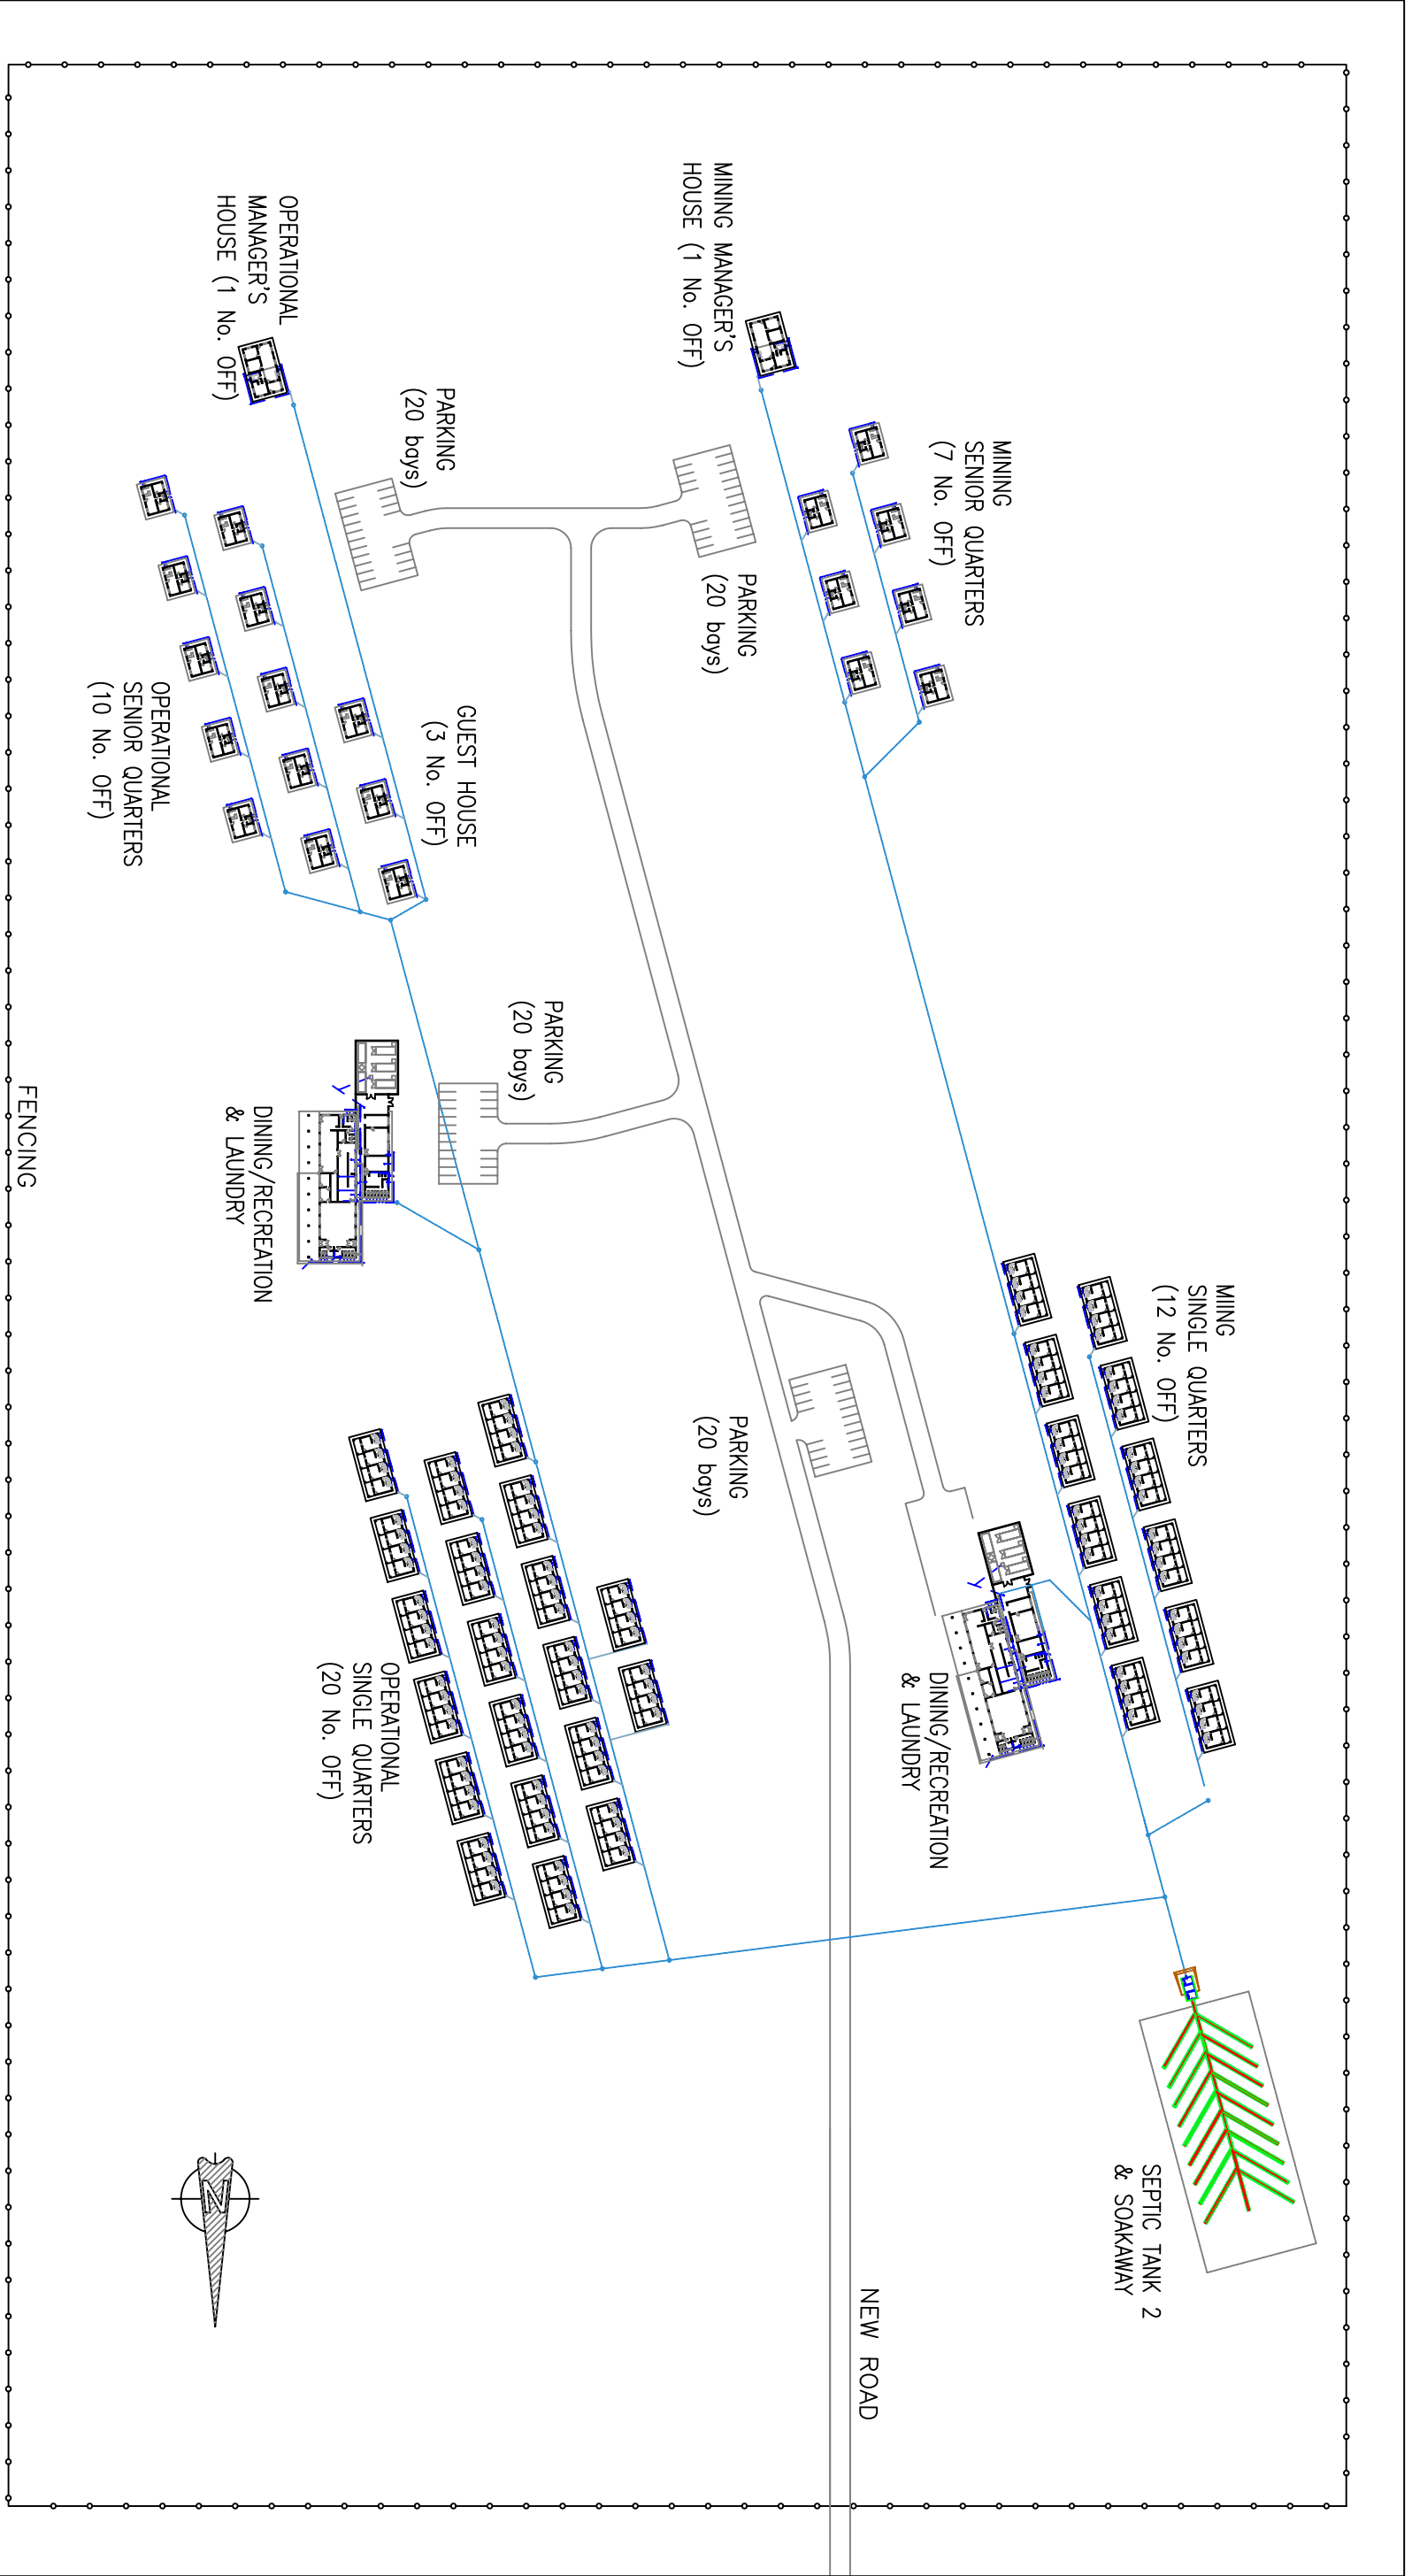


FIGURE 3.7

| | | |
|---|--|--|
| <p>AFRICAN MINING CONSULTANTS LTD P.O BOX 20106, KITWE, ZAMBIA.</p> | | |
| <p>PROJECT TITLE: MINE VILLAGE LAYOUT</p> | | |
| <p>ORIGINATOR: AD DRAWN: EPM</p> | <p>CLIENT: AFRICO RESOURCES FILE NAME: MINE_VILLAGE.DWG</p> | <p>SCALE: 1 : 2 000 DATE: MAY'06 REV NO: 0</p> |

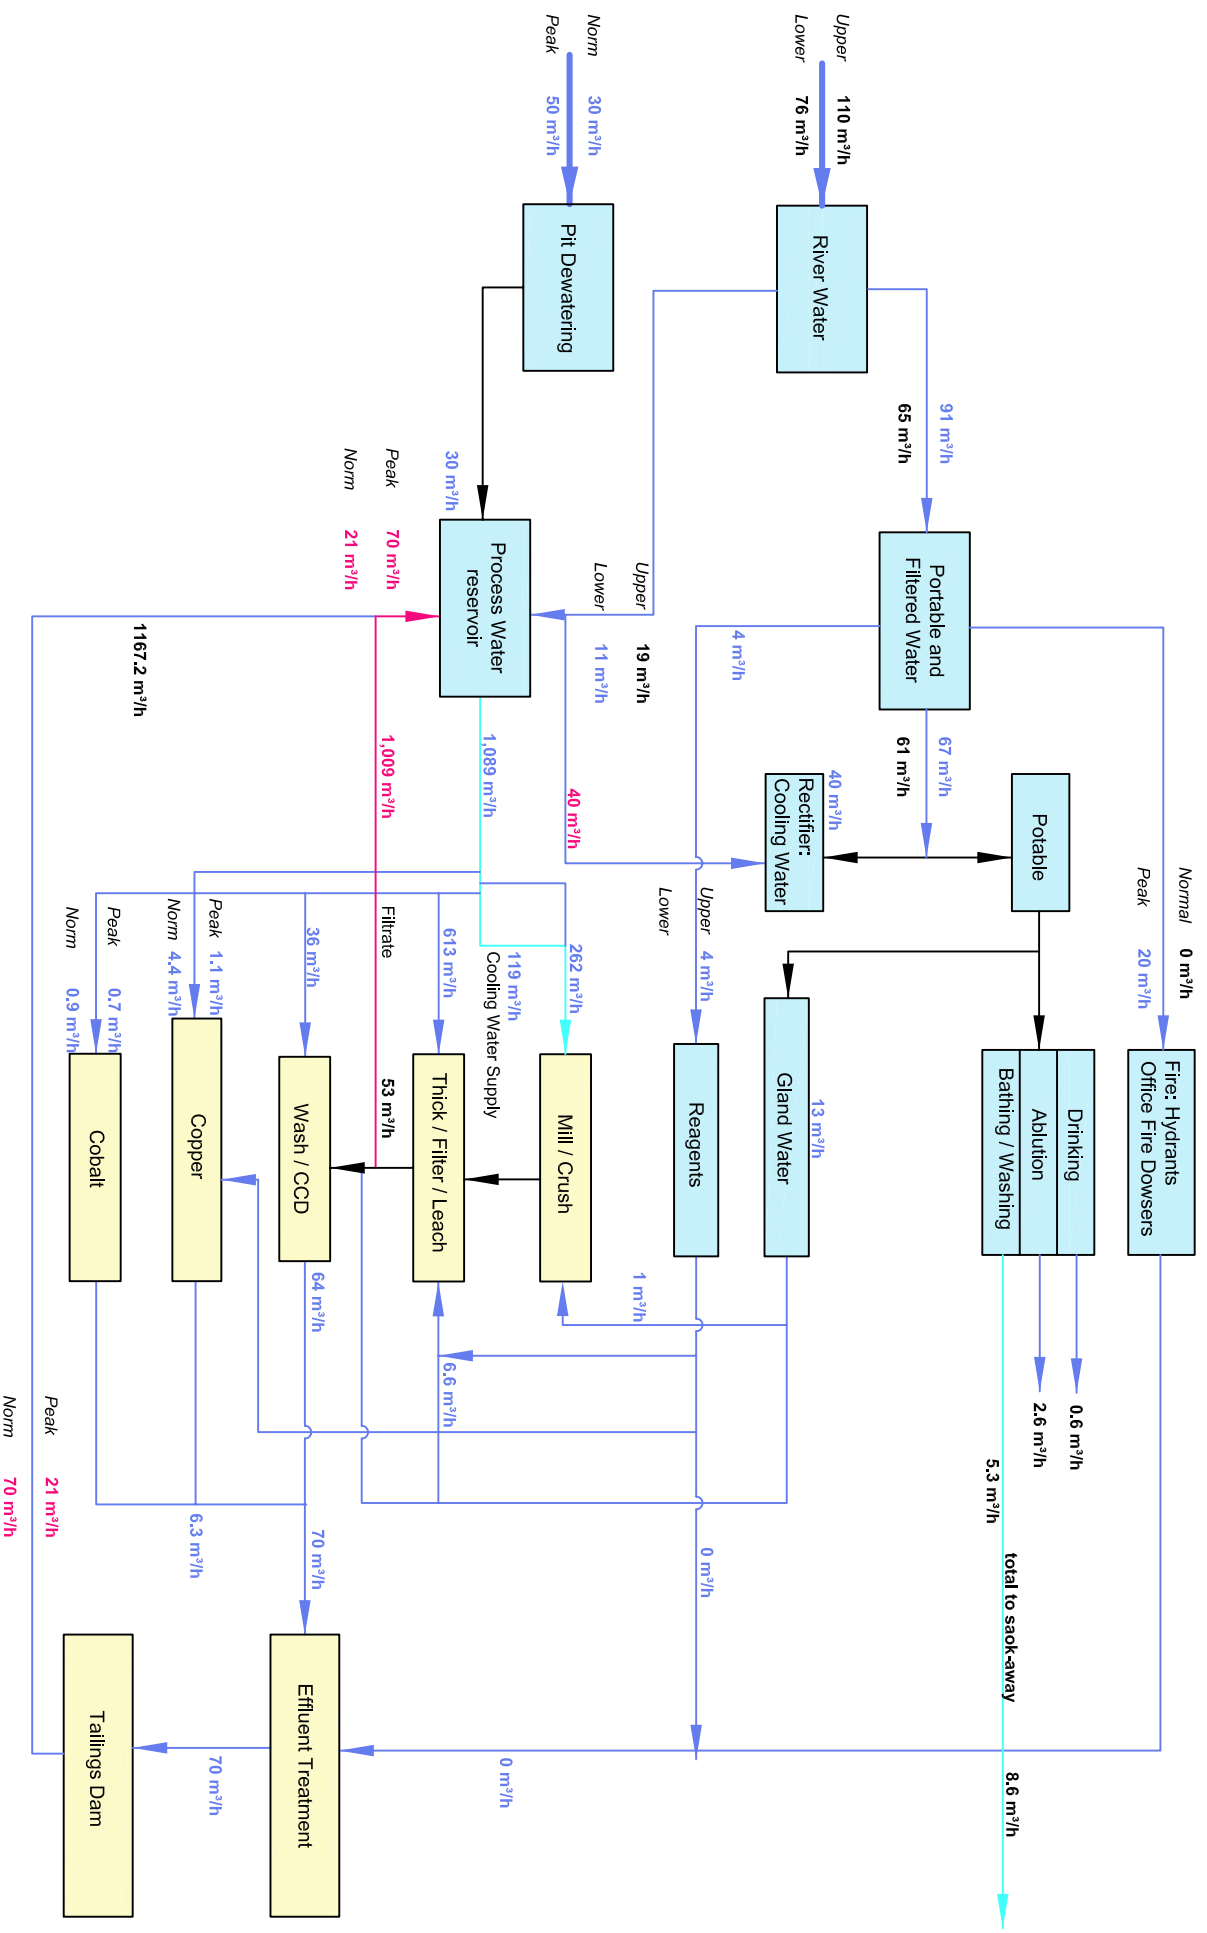
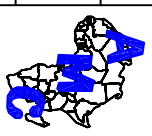


FIGURE 3.9

| | |
|---|--|
| AFRICAN MINING CONSULTANTS LTD P.O. BOX 20106, KITWE, ZAMBIA. | |
| PROJECT TITLE: KAIUKUNDI PROCESS WATER BALANCE | SCALE: NTS CLIENT: AFRICO RESOURCES LTD FILE NAME: WATER_BALANCE.DWG |
| ORIGINATOR: AD DRAWN: EPM | DATE: MAY/06 REV: NO.0 |



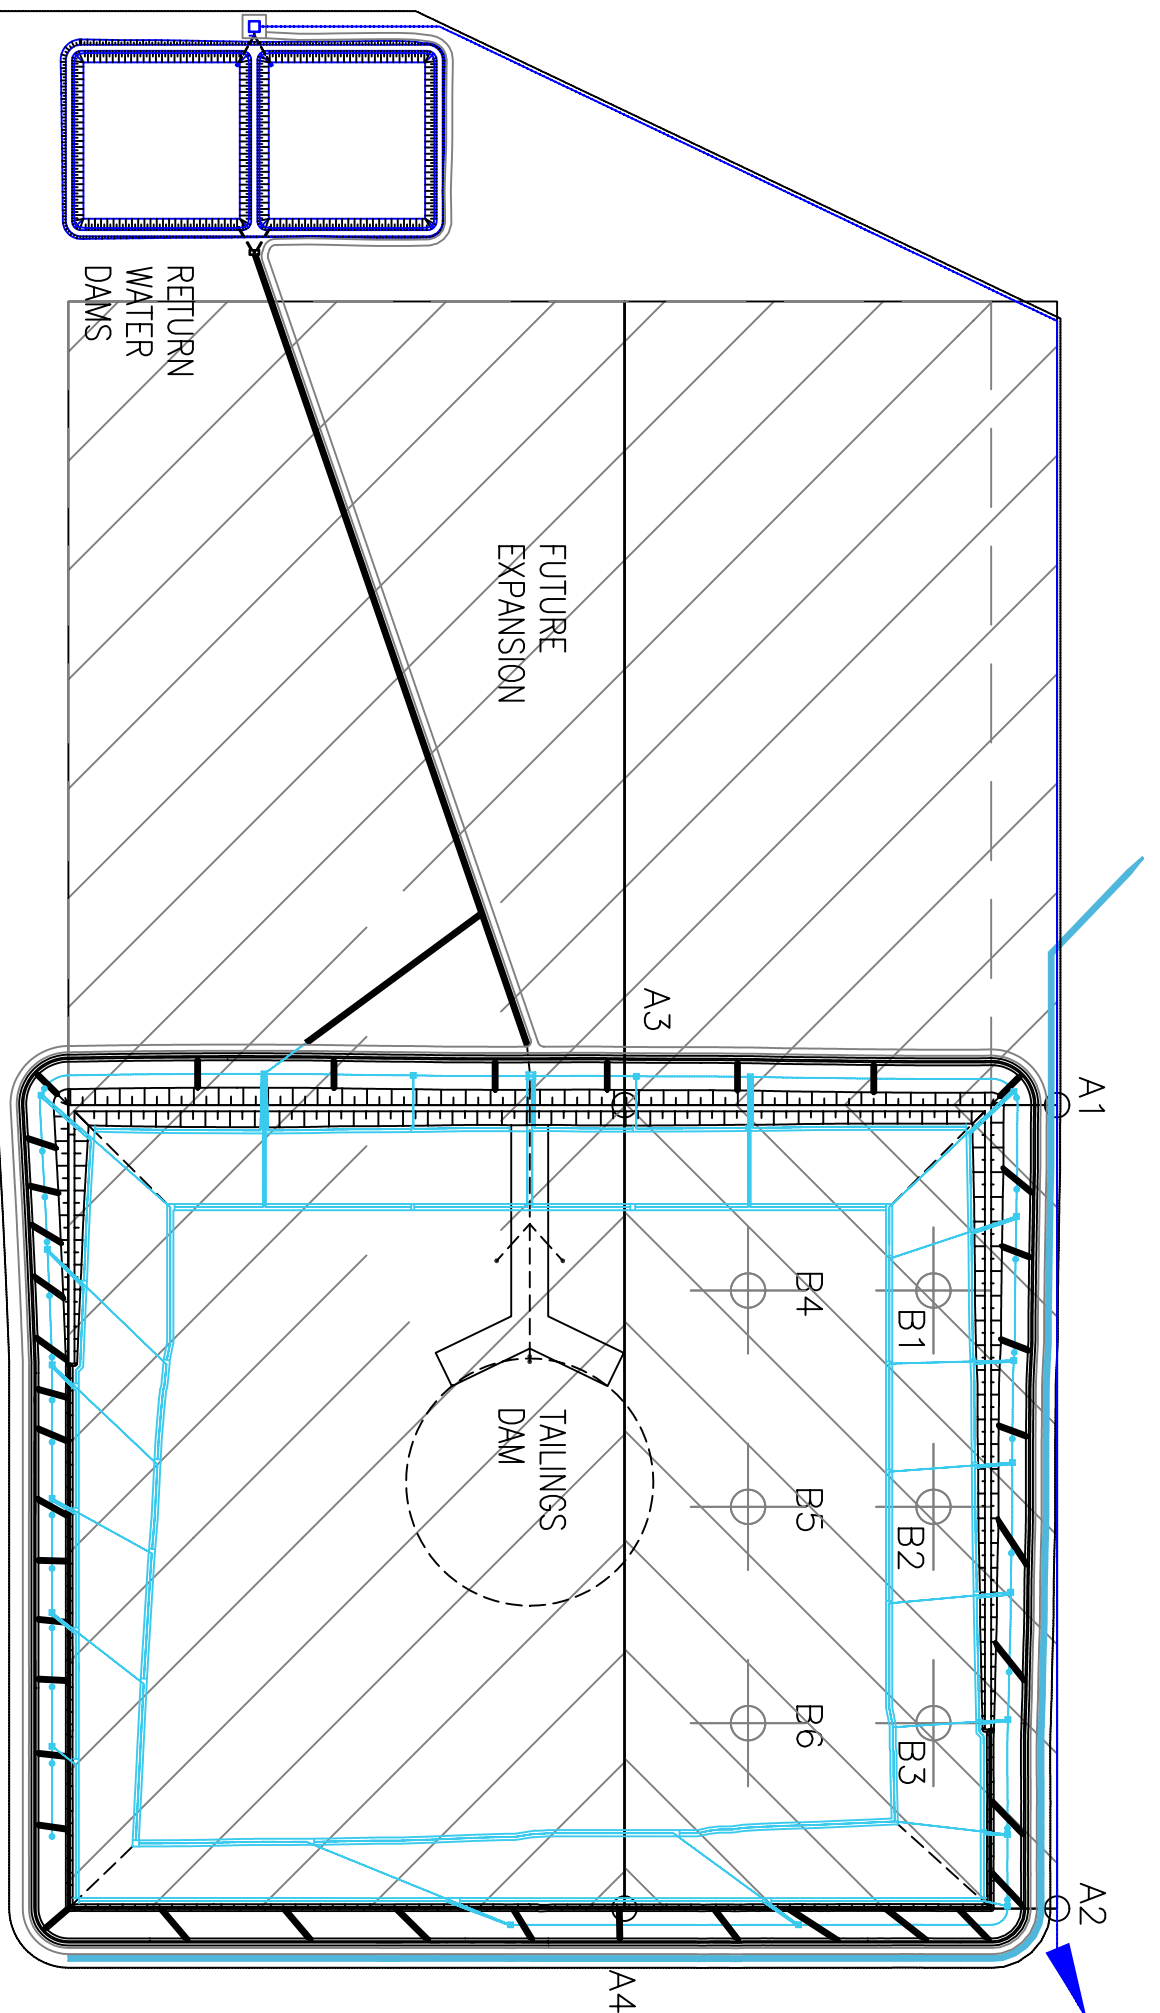


FIGURE 3.10

AFRICAN MINING CONSULTANTS LTD


P.O BOX 20106, KITWE, ZAMBIA.


PROJECT TITLE:

DESIGN OF TAILINGS STORAGE FACILITY

SCALE:

| | | |
|----------------|--------------------------|--------------|
| ORIGINATOR: AD | CLIENT: AFRICO RESOURCES | DATE: MAY'06 |
| DRAWN: EPM | FILE NAME: TAILINGS.DWG | REV NO:0 |

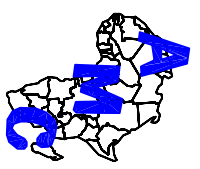

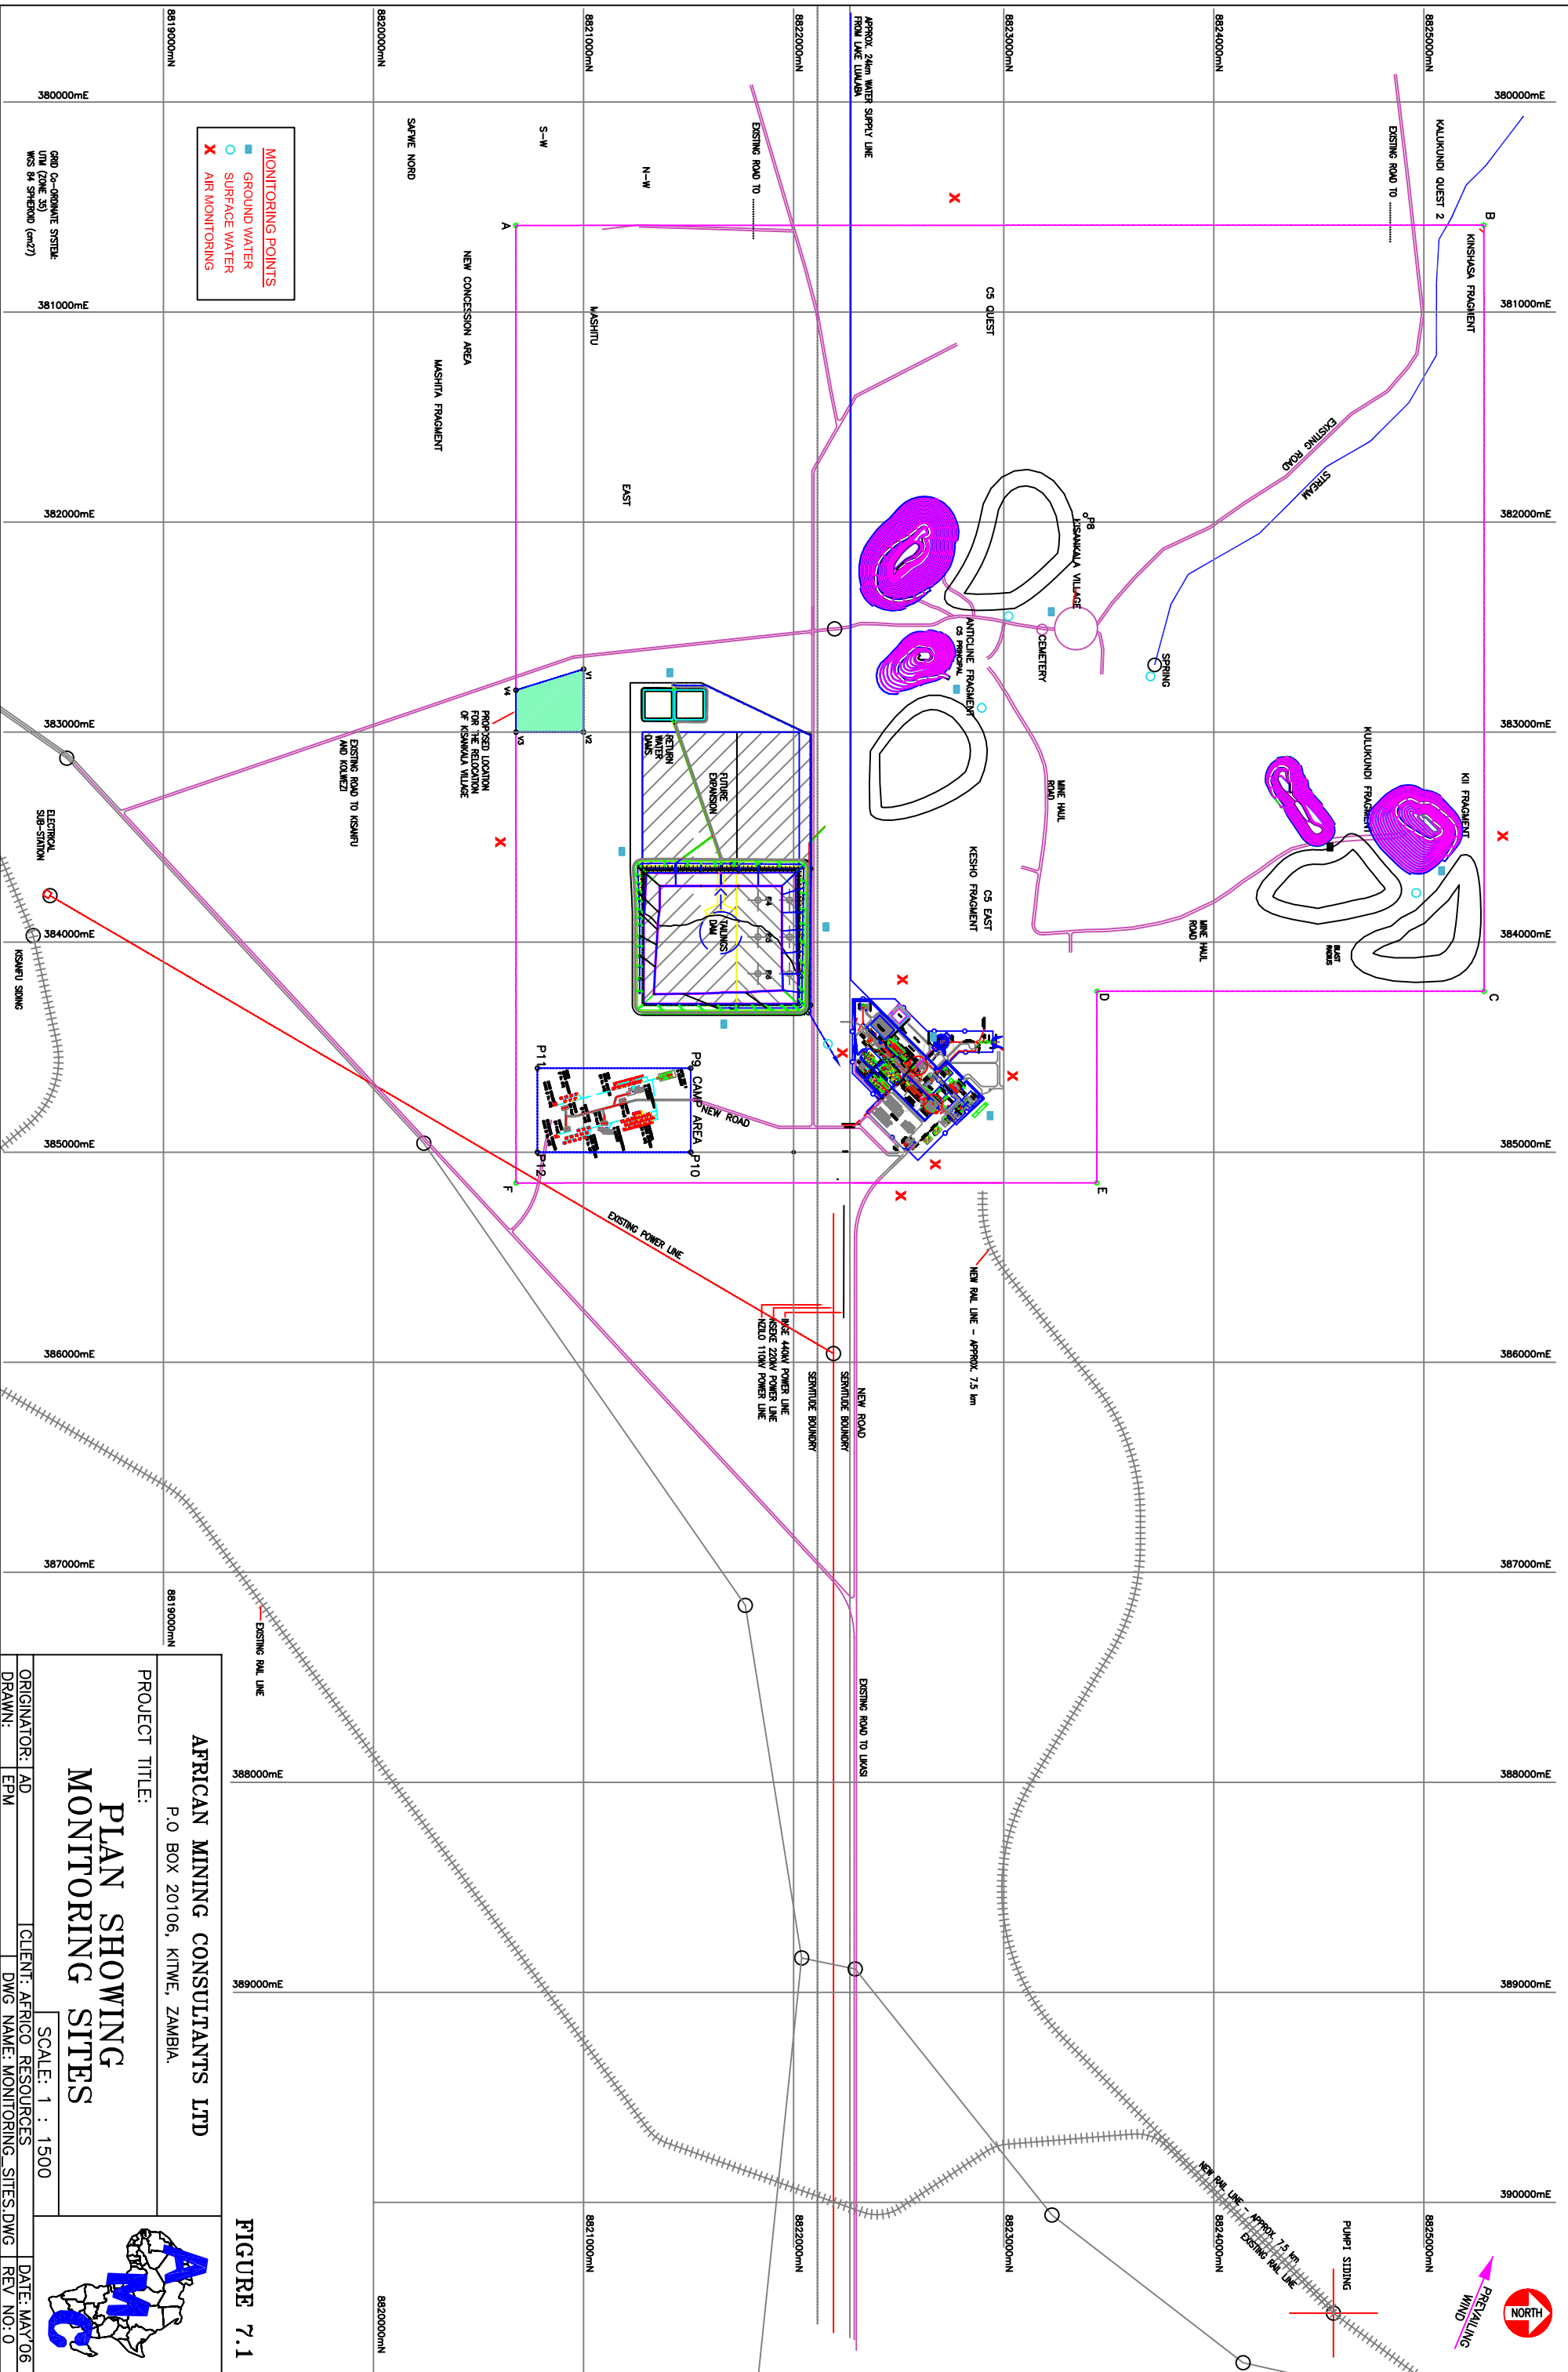

AFRICAN MINING CONSULTANTS LTD
 P.O. BOX 20106, KITWE, ZAMBIA.

PROJECT TITLE:
**PLAN SHOWING
 MONITORING SITES**

ORIGINATOR: IAD | CLIENT: AFRICO RESOURCES | SCALE: 1 : 1500 | DATE: MAY'06
 DRAWN: EPM | DWG NAME: MONITORING_SITES.DWG | REV NO: 0

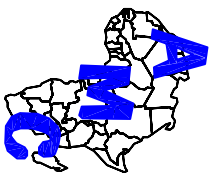


FIGURE 7.1

MONITORING POINTS
 ■ GROUND WATER
 ○ SURFACE WATER
 X AIR MONITORING

GRID CO-ORDINATE SYSTEM:
 UTM (ZONE 35)
 WGS 84 SPHEROID (m27)